BEING THE SOUTH SHORELINE OF COPANO BAY SUBMERGED TRACT 40, ARANSAS COUNTY, TEXAS LYING WITHIN THE C.O.D. GILLAND SURVEY, ABSTRACT NO. 70, ARANSAS COUNTY, TEXAS AND SAID SHORELINE BEING THE MEAN HIGH WATER LINE DETERMINED AT ELEVATION 1.25' NAVD'88 AND BEING MORE PARTICULARLY DESCRIBED BY METES AND BOUNDS AS

BEGINNING AT THE WEST END CORNER OF THIS SHORELINE, SAID CORNER HAVING A STATE PLANE GRID COORDINATE OF N 13,231,795.64', E 2,601,327.97', NAD'83, TEXAS SOUTH CENTRAL ZONE, AND BEARING S 65°19'19" E 2,925.67' TO NGS MONUMENT DP0716 HAVING A COORDINATE OF N 13,230,063.33 AND E 2,604,803.14 AND SAID CORNER LYING ON THE MEAN HIGH WATER LINE BOUNDARY BETWEEN SAID GILLAND SURVEY AND COPANO BAY SUBMERGED TRACT 40, THENCE WITH SAID MEAN HIGH WATER BOUNDARY AS FOLLOWS:

		en e	
LINE	BEARING	DISTANCE	VARAS
L1	N81°33'16"E	15.40'	5.54
L2	N02°24'45"W	8.75'	3.15
L3	S75°28'52"E	18.43'	6.63
L4	S55°39'00"E	13.50'	4.86
L5	S81°21'41"E	21.08'	7.59
L6	S82°42'21"E	18.74	6.75
L7	S68°43'06"E	25.29'	9.10
L8	S48°25'30"E	31.48'	11.33
L9	S06°50'07"W	18.92'	6.81
L10	S06°37'43"W	32.37'	11.65
L11	S12°44'15"W	24.72'	8.90
L12	S14°07'22"W	24.10'	8.68
L13	N85°49'59"E	8.53'	3.07
L14	N82°47'04"E	10.99'	3.96
L15	S89°48'04"E	14.41'	5.19
L16	S86°39'38"E	11.16'	4.02
L17	N23°40'58"E	15.39'	5.54
L18	N66°14'17"E	11.89'	4.28
L19	S62°24'11"E	31.54'	11.35
L20	S51°58'11"E	23.31'	8.39
L21	S59°05'54"E	22.18'	7.98
L22	S49°19'15"E	26.37	9.49
L23	S56'52'51"E	13.36'	4.81
L24	S63°12'38"E	25.94	9.34
L25	N87°53'37"E	48.97'	17.63
L26	N84°12'49"E	73.60'	26.50
L27	N89°42'07"E	25.71'	9.26
L28	N63°33'05"E	4.76'	1.71
L29	N77°10'04"E	11.12'	4.00
L30	N62°00'10"E	21.55	7.76
L31	S37°01'07"E	23.51'	8.46
L32	S00°16′50"W	32.67'	11.76
L33	S20°03'02"E	81.00'	29.16
L34	S42°03'43"E	63.07'	22.71
L35	S65°58'00"E	46.81	16.85

TO THE EAST END POINT OF THIS MEAN HIGH WATER BOUNDARY HAVING A COORDINATE OF N 13,231,284.81', E 2,602,144.71' AND BEARING S 65°19'19" E 2,925.67' TO NGS MONUMENT DP0716 HAVING A COORDINATE OF N 13,230,063.33 AND E 2,604,803.14

1. ALL SURVEYING WAS PERFORMED BY GOVIND DEVELOPMENT, LLC FROM GPS OBSERVATIONS. THIS DRAWING REPRESENTS THE CONDITIONS THAT EXISTED AT THE TIME OF THE SURVEY CONDUCTED OCTOBER 10, 2021.

FIELD PERSONNEL: GEORGE RUBALCABA, RPLS, LSLS

JASON CANTU AUSTIN DAVIS, SIT

ELEV. 4.58'

2. ALL ELEVATIONS ARE IN U.S. FEET AND REFERENCED TO NAVD'88 DATUM.

3. COORDINATES SHOWN ARE GRID IN U.S. FEET AND REFERENCED TO TEXAS COORDINATE SYSTEM, TEXAS SOUTH CENTRAL ZONE, AS DEFINED BY ARTICLE 21.071 OF THE NATURAL RESOURCES CODE OF THE STATE OF TEXAS, 1983 DATUM.

4. COORDINATES AND ELEVATIONS DETERMINED FROM A NETWORK AND CHECKED AGAINST THE FOLLOWING NGS MONUMENTS:

NGS MONUMENT DP0716

NGS MONUMENT DR3189 N 13,230,063.33' N 13,230,602.17' E 2,605,221.20' E 2,604,803.14'

5. MEAN HIGH WATER TO BE AT ELEVATION 1.25' NAVD'88 AFTER A THREE DAY STUDY AT THE SITE AND COMPUTATIONS USING THE AMPLITUDE RATIO METHOD AND THE NOAA ROCKPORT TIDE GAUGE AS THE CONTROL STATION.

ELEV. 7.46'

6. BASIS OF BEARINGS IS "TEXAS COORDINATE SYSTEM" PER SECTION 21.071 OF THE NATURAL RESOURCES CODE.

7. DISTANCES AND BEARINGS ARE GRID. SCALE FACTOR FOR NGS MONUMENT "DP0716" IS 1.00000000009292. CONVERGENCE IS + 0 58 01.0

8. THE LIMITS OF THESE LITTORAL BOUNDARIES ARE DETERMINED BY METHODOLOGY APPROVED BY THE TEXAS GENERAL LAND OFFICE AS PER TITLE 31, CHAPTER 3, RULE 7.2 (COASTAL LANDS) OF

OF VEGETATION OR THE LANDWARD BOUNDARY OF THE PUBLIC BEACH.

9. THIS SURVEY DOES NOT, NOR IS ITENDED TO BE USED TO IDENTIFY, DELINEATE OR FIX THE LINE

10. ARTIFICIAL FILL AND AN OLD BULKHEAD ARE IN THE VICINITY OF THE SURVEYED BOUNDARY,

11. AERIAL OBTAINED FROM GOOGLE EARTH.

12. UPLAND OWNER: MISHO'S OYSTER COMPANY, P.O. BOX 8417, BACLIFF, TX. 77518-8417.

13. CONTACTS: GEORGE RUBALCABA, PRLS, LSLS, PE GOVIND DEVELOPMENT, LLC 9510 LEOPARD STREET, CORPUS CHRISTI, TEXAS 78410 (361)876-0498 Grubalcaba 14. PLANNED EROSION CONTROL ACTIVITIES WILL CONSIST OF INSTALLING TWO OFFSHORE

BREAKWATERS GLO# LC 20220001 NOTICE: THIS SURVEY WAS PERFORMED IN ACCORDANCE SECTION 33.136 NATURAL RESOURCES CODE FOR THE PURPOSE OF EVIDENCING THE LOCATION OF THE SHORELINE IN THE AREA DEPICTED IN THIS SURVEY AS THAT SHORELINE EXISTED BEFORE COMMENCEMENT OF EROSION RESPONSE ACTIVITY, AS REQUIRED BY CHAPTER 33, NATURAL RESOURCES CODE. THE LINE DEPICTED ON THIS SURVEY FIXES THE SHORELINE FOR THE PURPOSE OF LOCATING A SHORELINE BOUNDARY, SUBJECT TO THE MOVEMENT LANDWARD AS PROVIDED BY SECTION 33.136, NATURAL



I, CARRIE ARRINGTON, CLERK OF THE COUNTY COURT IN AND FOR ARANSAS COUNTY, TEXAS, DO HEREBY CERTIFY THAT THE FOREGOING INSTRUMENT OF WRITING DATED THE 2614 DAY OF APRIL , AD., 2022, WITH ITS CERTIFICATE OF AUTHENTICATION WAS FILED FOR RECORD IN MY OFFICE THE 13TH DAY OF MAN, A.D., 2022, AT 3:24 O'CLOCK P.M. AND DULY RECORDED THE 1374 DAY OF MAY A.D., 2022 AT 3:24 O'CLOCK P. M. IN THE PLAT RECORDS OF


WITNESS MY HAND AND SEAL OF THE COUNTY COURT, IN AND FOR ARANSAS COUNTY, TEXAS, AT OFFICE IN ROCKPORT, TEXAS, THE DAY AND YEAR LAST WRITTEN

BY: (ARRIE ARRINGTON

CLERK FILE NO. _

9510 LEOPARD STREET 391416 CORPUS CHRISTI, TEXAS 78410 (361)876-0498

THAT EXISTED IN THE FIELD AT THE TIME OF THE MEAN HIGH WATER SURVEY CONDUCTED ON OCTOBER 10, 2021, ACCORDING TO LAW AND UNDER MY DIRECT CONTROL AND SUPERVISION AND WITH METHODOLOGY APPROVED BY THE TEXAS GENERAL LAND OFFICE AND IS CORRECT AND IN ACCORDANCE WITH TEXAS GEORGE RUBALCABA, LICENSED STATE LAND SURVEYOR

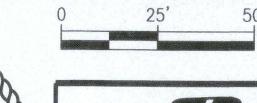

COPANO BAY

SUBMERGED TRACT 40



DESCRIPTION CHECKED DATE ISSUED TO CLIENT GR 04/2

EXHIBIT A

GOVIND DEVELOPMENT, LLC.
TBPLS FIRM NO. 10193800

BELAIRE ENVIRONMENTAL, INC.

COASTAL BOUNDARY SURVEY ARANSAS COUNTY TEXAS

SCALE: AS SHOWN CLIENT APPROVAL 04/2022 21BEI0077

JOB NO. DRAWING NO. SHT 1



I, GEORGE RUBALCABA, A LICENSED STATE LAND SURVEYOR.

NATURAL RESOURCES CODE 21.042

HEREBY STATE THAT THIS DRAWING REPRESENTS THE CONDITIONS

MEAN HIGH WATER


MAN MADE BULKHEAD AREA

UPLAND OWNER: MISHO'S OYSTER

COMPANY, P.O. BOX 8417, BACLIFF, TX.

77518-8417.

ELEV: 1.25'

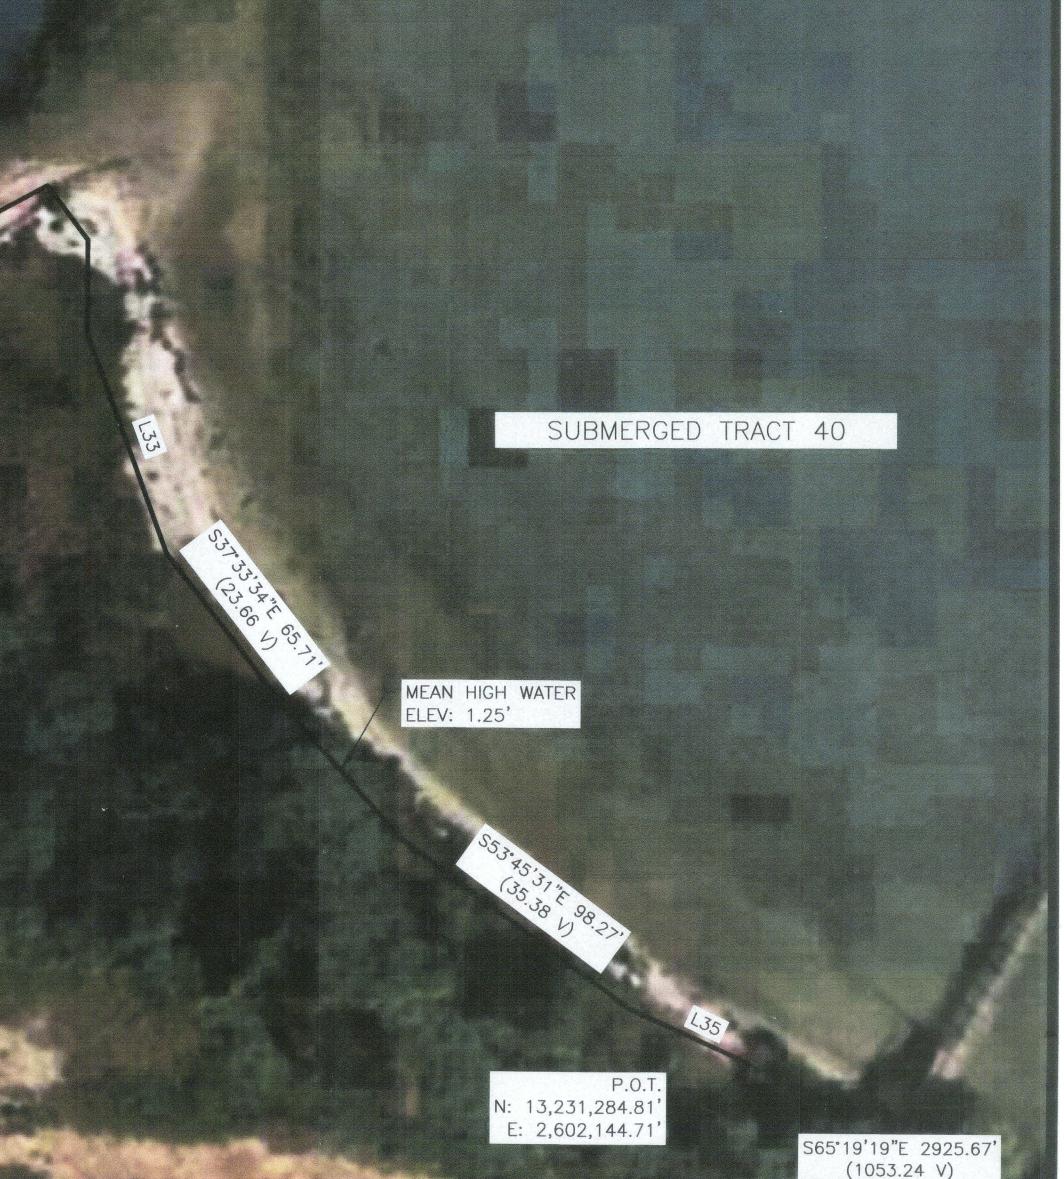



TEXAS GENERAL LAND OFFICE GEORGE P. BUSH, COMMISSIONER

Surveying Division Coastal Boundary Survey Approval

-			74	
Ρ	ro	ia	ct	•

Coastal boundary survey on the line of mean high water along Copano

Bay Submerged Tract 40 and C.O.D. Gilland Survey, Abstract 70,

Aransas County.

Project No:

Survey associated with GLO Project No. CL20220001 and USACE SWG

2021-00041.

Project Manager:

Amy Nunez, Director, Coastal Field Operations

Surveyor:

George Rubalcaba, Licensed State Land Surveyor

Description:

Coastal Boundary Survey delineating the south shoreline of Copano Bay Submerged Tract 40, Aransas County, Texas lying within the C.O.D.

Gilland Survey, Abstract No. 70, Aransas County, Texas and said

shoreline being the Mean High Water (MHW) line determined at elevation 1.25' NAVD'88. Survey associated with GLO Project No. CL20220001 and USACE SWG 2021-00041. Centroid coordinates N 28° 06'58.93", W 97° 02'07.51", WGS84. A copy of the survey has been filed in Volume 7,

Page 222, Aransas County Plat Records.

A Coastal Boundary Survey for the above-referenced project has been reviewed and accepted; upon completion of public notice requirements, the survey will be filed in the Texas General Land Office, Archives and Records, in accordance with provisions of the Texas Natural Resources Code, Chapter 33.136.

Approved:

Signed:

Surveying Division

06/09/2022

Date

Approval Filed as:

Tex.Nat.Res.Code Article 33.136, Aransas County, Sketch No. 20 Art. 33.136, Natural Resources Code

TEXAS GENERAL LAND OFFICE

Co. Aransas , SK No. 20

File Date 06/14/2022 by K. Schreiber